DRAWING	NDEX	
DWG NO	DRAWING TITLE	REV
T-1	TITLE SHEET	2
A-1	EQUIPMENT AND ANTENNA DETAILS	2
A-2	ANTENNA LOADING CHART	2
A-3	SITE PLAN	2
A-4	ROOF PLAN	2
A-5	EQUIPMENT ROOM LAYOUT BESIDE STORAGE ROOM 3	2
A-6	NORTH ELEVATION	2
A-7	PARTIAL EAST ELEVATION	2
A-8	SOUTH ELEVATION	2
A-9	PARTIAL WEST ELEVATION	2

ROGERS

KEY PLAN



NAD 83

LONGITUDE: W 122.778314°

LATITUDE: N 49.252102°

SITE INFORMATION

SITE ID: W4471

SITE NAME: GATES PARK

SITE ADDRESS: 1955 WESTERN DRIVE

PORT COQUITLAM, BC

LEGAL DESCRIPTION: PID: 007-002-068

> LOT 207 DISTRICT LOT 290 GROUP 1 NEW WESTMINISTER

DISTRICT PLAN 34224

SITE CONFIGURATION: ROOFTOP - MACRO

APPLICANT: ROGERS COMMUNICATIONS INC.

PROJECT:

DRAWING TITLE:

1600-4710 KINGSWAY BURNABY, BC V5H 4W4

2	REVISED PER ROGERS	FEB 20/19	ΑD
1	REVISED PER ROGERS	FEB 01/19	NR
0	ISSUED FOR REVIEW	JAN 03/19	KC
REV	DESCRIPTION	DATE	BY



W4471 **GATES PARK** 1955 WESTERN DRIVE

CAD FILE: PORT COQUITLAM BRITISH COLUMBIA PROJECT NO:

229 - 18525 53RD AVENUE

TITLE SHEET

DRAWING NO:


CHECK BY:

DRAWN BY:

T-1

ROGERS WIC HAS BEEN DESIGNED BY HYBRID BUILDING LOGISTICS AND ARE BASED UPON DRAWINGS DATED FEBRUARY 13, 2017. CORE ONE CONSULTING LTD. DOES NOT TAKE RESPONSIBILITY OF THE EQUIPMENT CABINET DESIGN

EQUIPMENT OPTIONAL ACCESSORIES SHOWN ARE DIAGRAMMATIC ONLY AND IS NOT SITE SPECIFIC

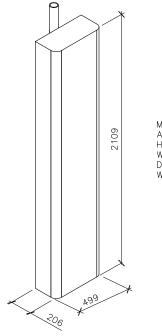


ANTENNA MODEL AS PER RADIO SITE QUALIFICATION DATED NOVEMBER 15, 2018

MANUFACTURER: HUAWEI
ANTENNA MODEL: ASI4516R0v06
HEIGHT: 2109mm
WIDTH: 499mm
DEPTH: 206mm
WEIGHT: 49.0kg

ANTENNA ISOMETRIC

N.T.S.

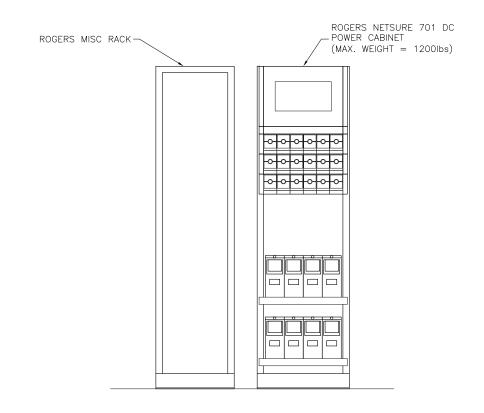



2	REVISED PER ROGERS	FEB 20/19	ΑD
1	REVISED PER ROGERS	FEB 01/19	ZR
0	ISSUED FOR REVIEW	JAN 03/19	KC
REV	DESCRIPTION	DATE	BY



	ANTENNA LOADING CHART																	
	antenna id				ANTENNA	DOC	AZMIUTH	MDT	MET ((*)	DIV	SPACE DIV	RRU'S TOWER	RRU'S INITIAL	JUMPER	JUMPER LENGTH	STATUS	
#	TECHNOLOGY	LABEL	P=PANEL W=WHIP		RAD CENTRE	HEIGHT REF.	POS	(°)	(°)	700/850	1900/2100/2600	(°)	(m)	LOADING		TYPES	(m)	31A103
1	LTE	LTE-1	HUAWEI ASI4516R6v06	Р	±10.78m	CENTRE	UP	40°	0	T.B.D.	T.B.D.	N/A	N/A	3	3	H&S	<5	INITIAL
2	LTE	T.B.D.	HUAWEI ASI4516R6v06	Р	±10.78m	CENTRE	UP	40°	0	T.B.D.	T.B.D.	N/A	N/A	3	0	H&S	<5	FUTURE
3	LTE OFFSET	OFFSET-1	HUAWEI ASI4516R6v06	Р	±10.78m	CENTRE	UP	100°	0	T.B.D.	T.B.D.	N/A	N/A	3	3	H&S	<5	INITIAL
4	LTE	LTE-2	HUAWEI ASI4516R6v06	Р	±13.62m	CENTRE	UP	160°	0	T.B.D.	T.B.D.	N/A	N/A	3	3	H&S	<5	INITIAL
5	LTE	T.B.D.	HUAWEI ASI4516R6v06	Р	±13.62m	CENTRE	UP	160°	0	T.B.D.	T.B.D.	N/A	N/A	3	0	H&S	<5	FUTURE
6	LTE OFFSET	OFFSET-2	HUAWEI ASI4516R6v06	Р	±13.62m	CENTRE	UP	220°	0	T.B.D.	T.B.D.	N/A	N/A	3	3	H&S	<5	INITIAL
7	LTE	LTE-3	HUAWEI ASI4516R6v06	Р	±13.62m	CENTRE	UP	280°	0	T.B.D.	T.B.D.	N/A	N/A	3	3	H&S	<5	FUTURE
8	LTE	T.B.D.	HUAWEI ASI4516R6v06	Р	±13.62m	CENTRE	UP	280°	0	T.B.D.	T.B.D.	N/A	N/A	3	0	H&S	<5	INITIAL
9	LTE OFFSET	OFFSET-3	HUAWEI ASI4516R6v06	Р	±13.62m	CENTRE	UP	340°	0	T.B.D.	T.B.D.	N/A	N/A	3	3	H&S	<5	INITIAL
10	GPS	GPS-1	GPSGLONASS-36-N-S	_	±13.62m	_	ı	_	_	_	_	ı	_	_	_	T.B.D	-	T.B.D.

ANTENNA LOADING CHART AS PER RADIO SITE QUALIFICATION DATED NOVEMBER 15, 2018

	2	REVISED PER ROGEF	FEB 20/19	AD	
	1	REVISED PER ROGEF	FEB 01/19	NR	
	0	ISSUED FOR REVIEW	/	JAN 03/19	KC
	REV	DESCRIPTION	DATE	BY	
		SCALE:	AS NO	TED	

ROGERS_{TH}

229 - 18525 53RD AVENUE SURREY, BC V3S 7A4 TEL: (778) 805-2166 INFO@COREONECONSULTING.COM

PROJECT: W4471 GATES PARK 1955 WESTERN DRIVE

PORT COQUITLAM BRITISH COLUMBIA


DRAWING TITLE:


ANTENNA LOADING CHART

CHECK BY: DRAWN BY: JAN 03/19 DATE: CAD FILE:

PROJECT NO: DRAWING NO:


A-2

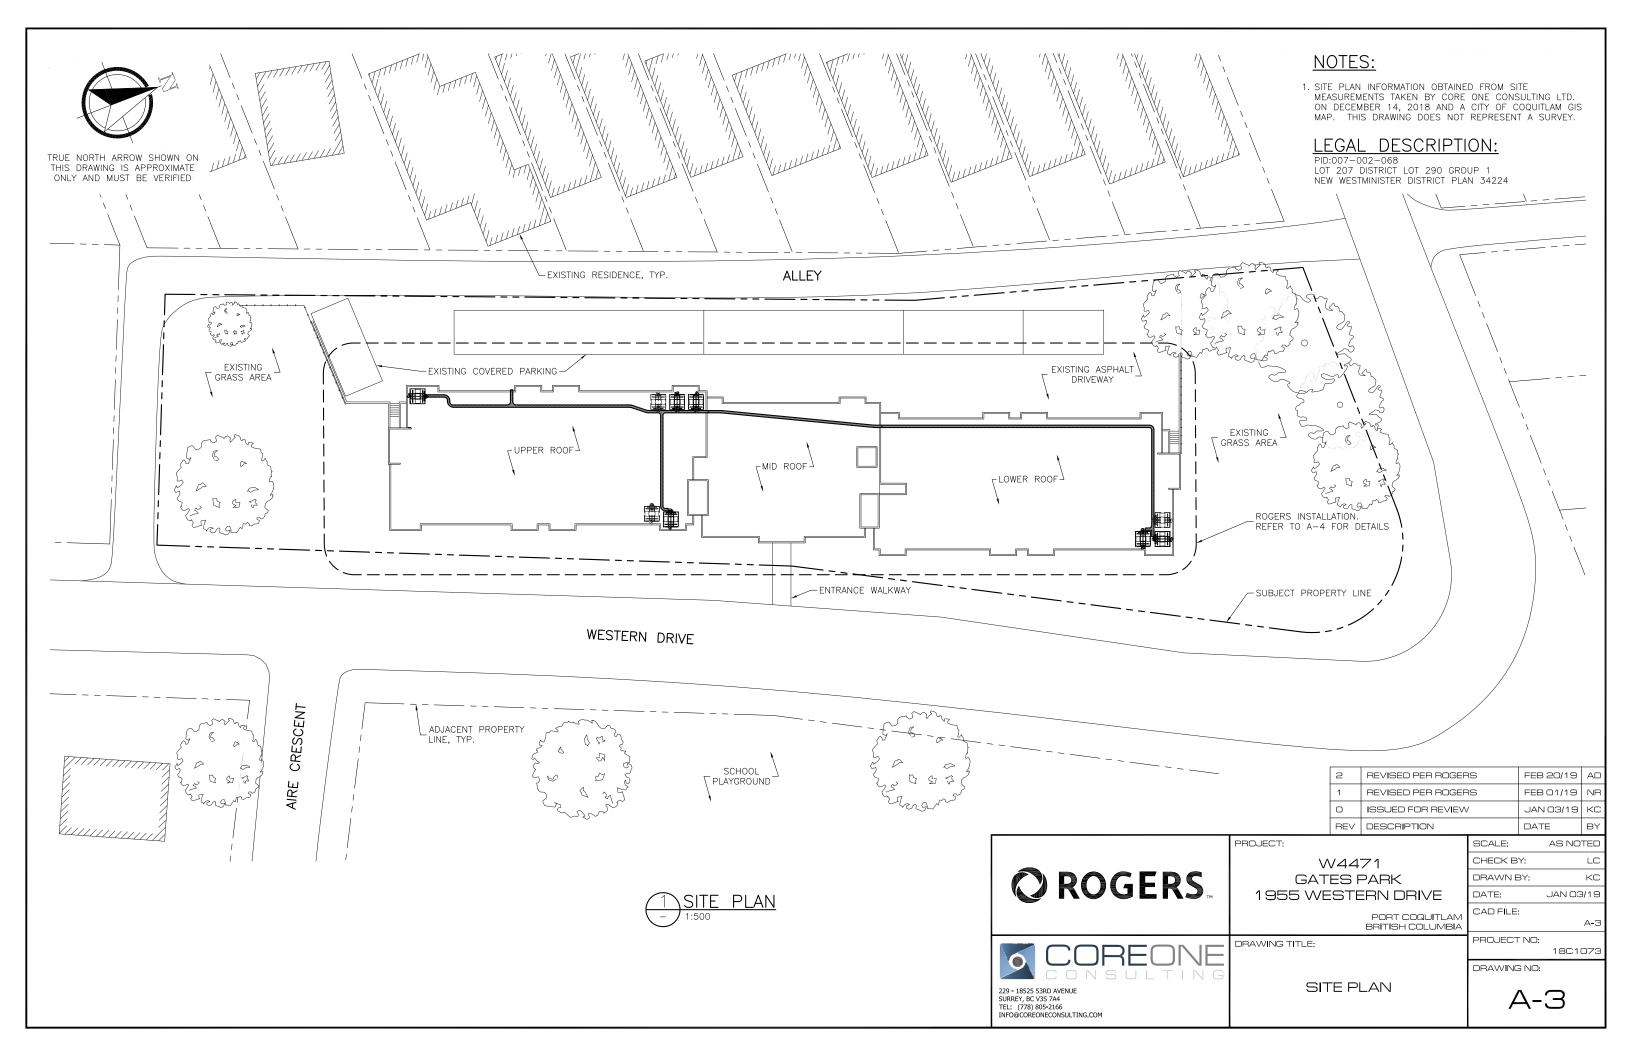

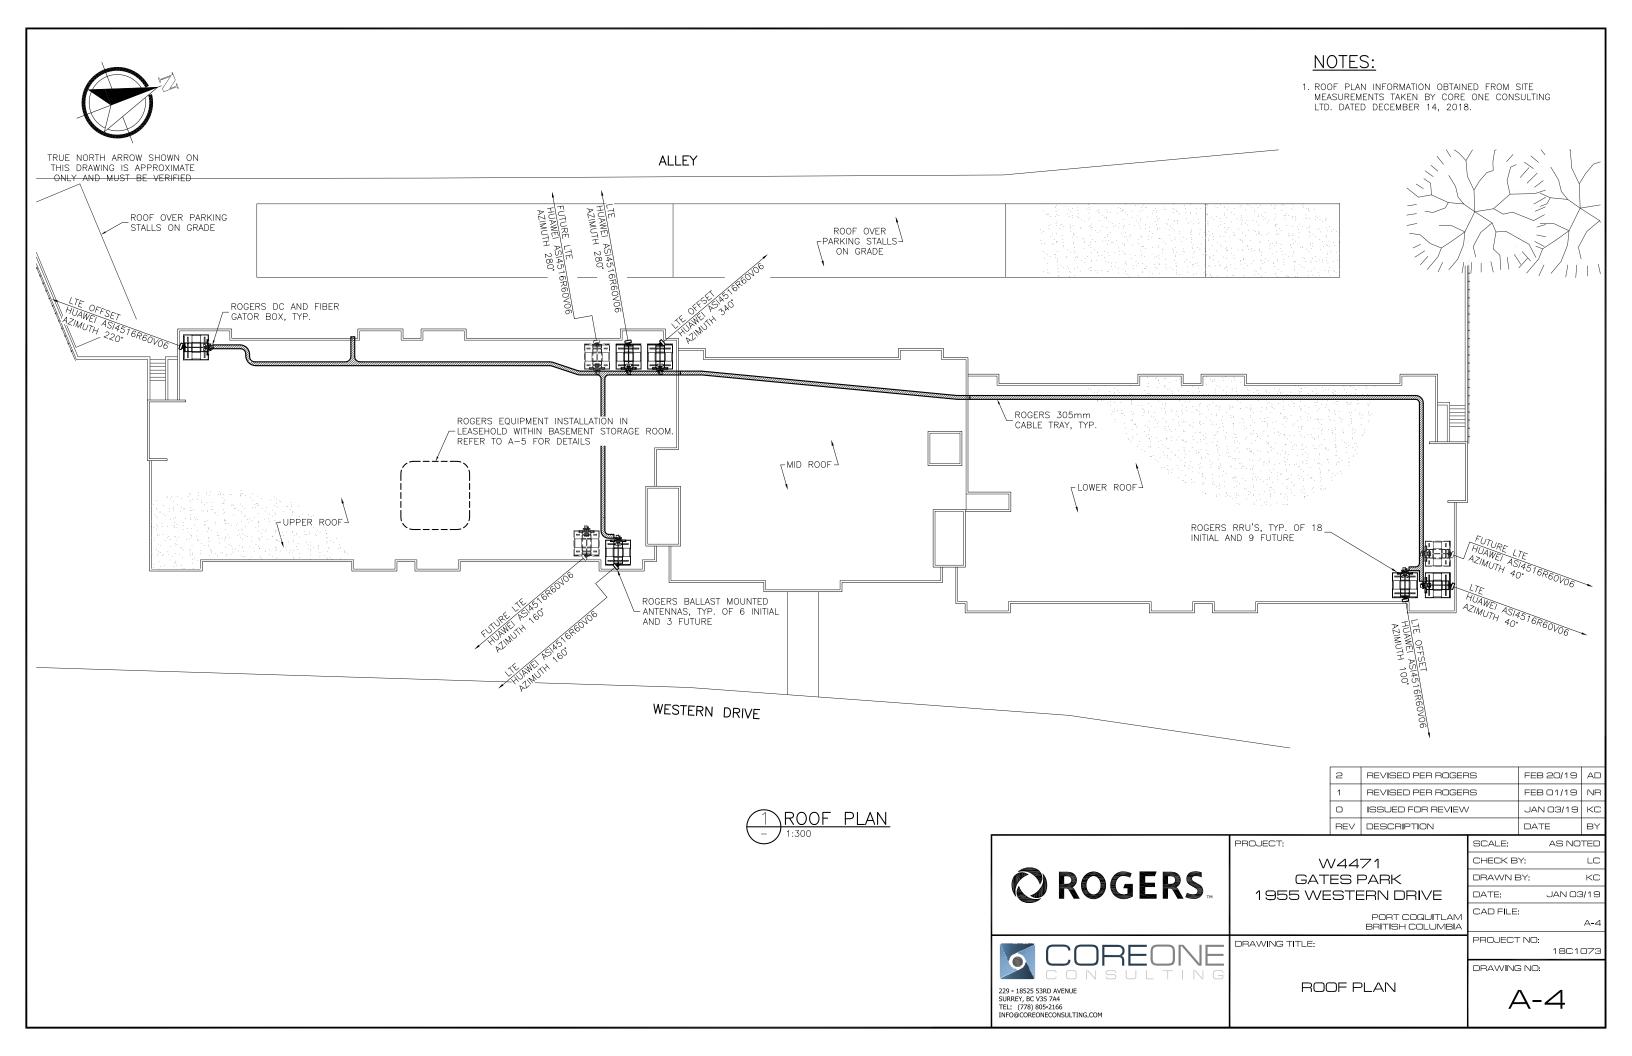



TRUE NORTH ARROW SHOWN ON THIS DRAWING IS APPROXIMATE ONLY AND MUST BE VERIFIED

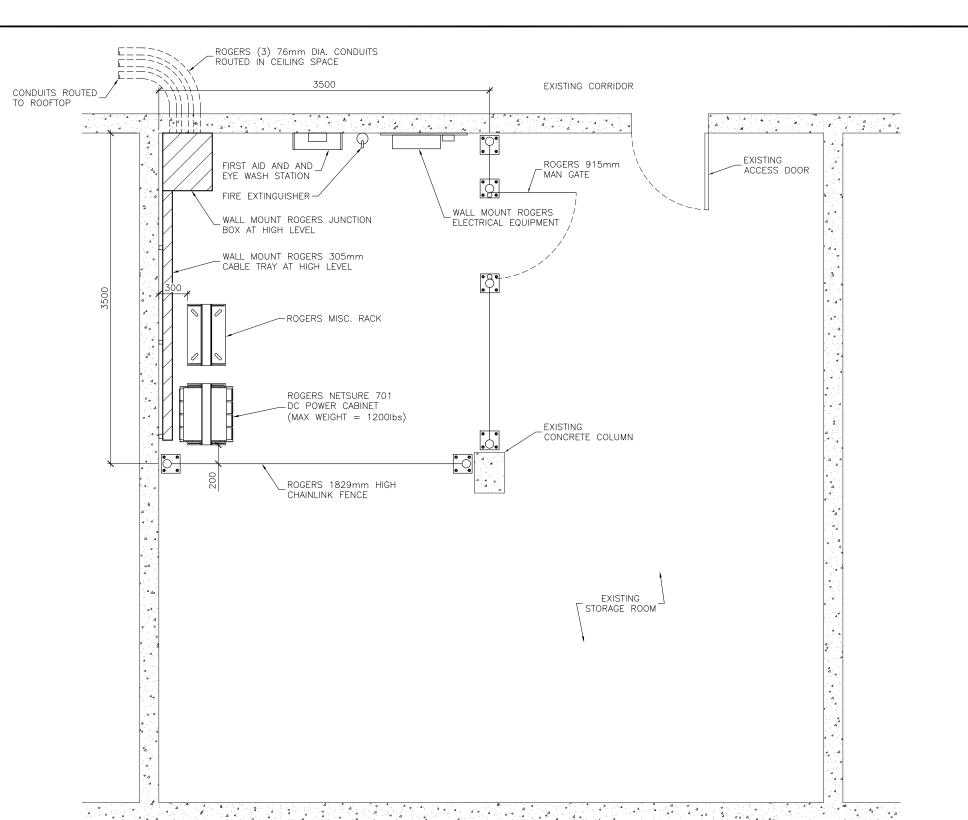

NOTES:

1. ROOF PLAN INFORMATION OBTAINED FROM SITE MEASUREMENTS TAKEN BY CORE ONE CONSULTING LTD. DATED DECEMBER 14, 2018.

2	REVISED PER ROGERS	FEB 20/19	ΑD
1	REVISED PER ROGERS	FEB 01/19	NR
0	ISSUED FOR REVIEW	JAN 03/19	KC
REV	DESCRIPTION	DATE	BY

EQUIPMENT ROOM LAYOUT

BESIDE STORAGE ROOM 3

- 1:40



229 - 18525 53RD AVENUE

SURREY, BC V3S 7A4
TEL: (778) 805-2166
INFO@COREONECONSULTING.COM

W4471 GATES PARK 1955 WESTERN DRIVE

PORT COQUITLAM BRITISH COLUMBIA

DRAWING TITLE:

PROJECT:


EQUIPMENT ROOM LAYOUT BESIDE STORAGE ROOM 3 SCALE: AS NOTED
CHECK BY: LC
DRAWN BY: KC
DATE: JAN 03/19
CAD FILE:

PROJECT NO:

DRAWING NO:

A-5

- 1. ELEVATION IS DIAGRAMMATIC ONLY.
- 2. PAINT ALL ANTENNAS, CABLE TRAY AND VISIBLE ANTENNA CABLES TO MATCH EXISTING BUILDING.

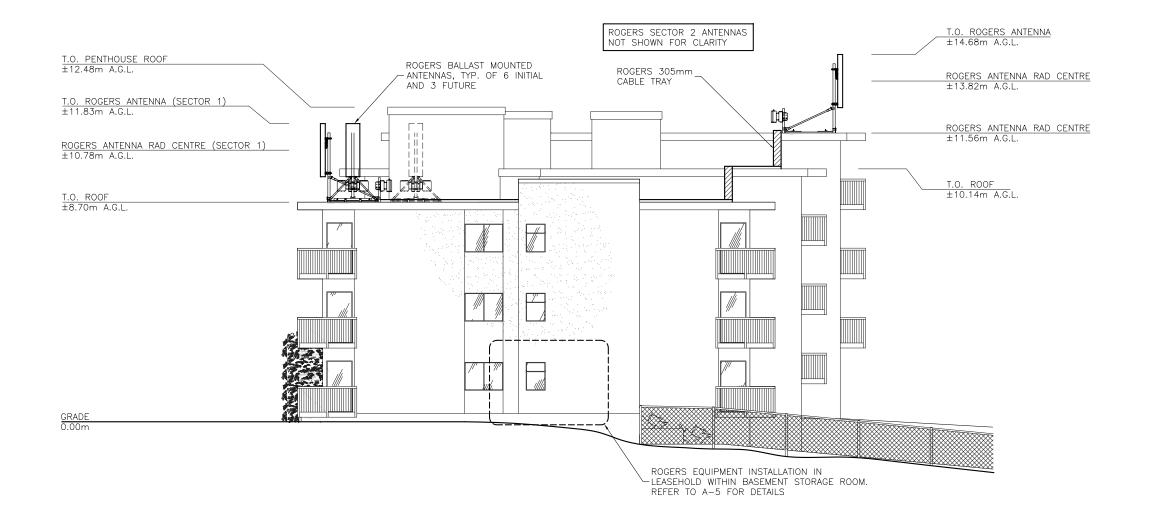




N	REVISED PER ROGERS	FEB 20/19	ΑD
1	REVISED PER ROGERS	FEB 01/19	NR
0	ISSUED FOR REVIEW	JAN 03/19	KC
REV	DESCRIPTION	DATE	BY




- 1. ELEVATION IS DIAGRAMMATIC ONLY.
- 2. PAINT ALL ANTENNAS, CABLE TRAY AND VISIBLE ANTENNA CABLES TO MATCH EXISTING BUILDING.

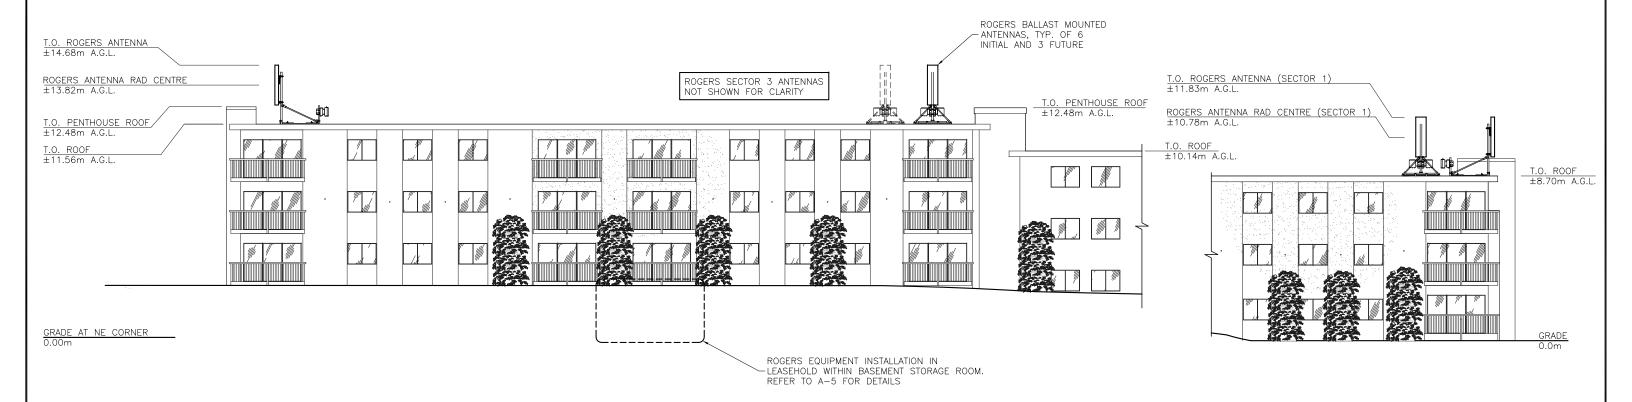




N	REVISED PER ROGERS	FEB 20/19	ΑD
1	REVISED PER ROGERS	FEB 01/19	NR
0	ISSUED FOR REVIEW	JAN 03/19	KC
REV	DESCRIPTION	DATE	BY

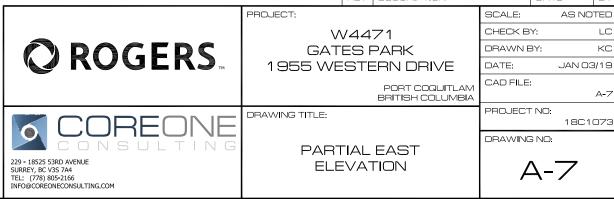

- 1. ELEVATION IS DIAGRAMMATIC ONLY.
- 2. PAINT ALL ANTENNAS, CABLE TRAY AND VISIBLE ANTENNA CABLES TO MATCH EXISTING BUILDING.

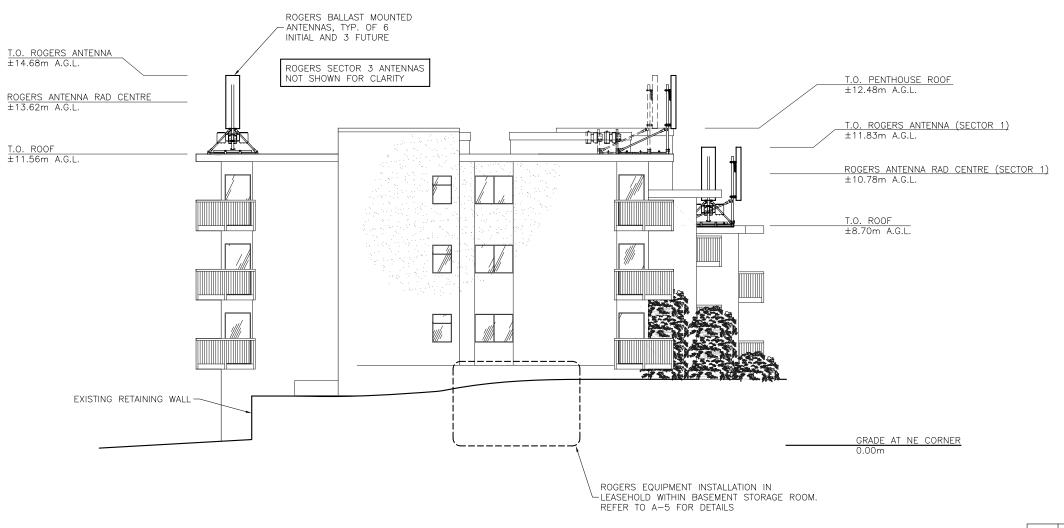



2	REVISED PER ROGERS	FEB 20/19	ΑD
1	REVISED PER ROGERS	FEB 01/19	NR
0	ISSUED FOR REVIEW	JAN 03/19	KC
REV	DESCRIPTION	DATE	BY

© ROGERS _™	GA ⁻ 1955 W
COREONE	DRAWING TITLE:
229 - 18525 53RD AVENUE SURREY, BC V3S 7A4 TEL: (778) 805-2166 INFO@COREONECONSULTING.COM	SOUTI

W4471 GATES PARK 1955 WESTERN DRIVE

PROJECT:

PORT COQUITLAM BRITISH COLUMBIA

PROJECT NO: 18C1073 DRAWING NO:

SCALE: CHECK BY:

DATE:

DRAWN BY:

SOUTH ELEVATION

A-8

AS NOTED

JAN 03/19

- 1. ELEVATION IS DIAGRAMMATIC ONLY.
- 2. PAINT ALL ANTENNAS, CABLE TRAY AND VISIBLE ANTENNA CABLES TO MATCH EXISTING BUILDING.



1 PARTIAL WEST ELEVATION
1:150

N	REVISED PER ROGERS	FEB 20/19	AD
1	REVISED PER ROGERS	FEB 01/19	ZR
0	ISSUED FOR REVIEW	JAN 03/19	KC
REV	DESCRIPTION	DATE	BY

			DESCRIPTION		DATE	Б
	PROJECT:		_	SCALE:	AS NO	OTED
	lacksquare	CHECK B	Y:	LC		
© ROGERS _™	GAT	ES F	PARK	DRAWN E	BY:	KC
WRUGERS	1955 WE	STE	RN DRIVE	DATE:	JAN O	3/19
			PORT COQUITLAM BRITISH COLUMBIA	CAD FILE	:	A - 9
CORFONE	DRAWING TITLE:			PROJECT		1073
				DRAWING	S NO:	
229 - 18525 53RD AVENUE SURREY, BC V35 7A4 TEL: (778) 805-2166 INFO@COREONECONSULTING.COM	PARTIAL W	PARTIAL WEST ELEVATION		1	7-9	